
PLUMBING FIXTURE SCHEDULE										
MARK	DESCRIPTION	MFR	MODEL			USE			NOTES	
				CW	HW	TEPID	WASTE	VENT		
P1	LAB SINK	FISHERBRAND	06000459	1/2"	1/2"	-	1 1/2"	1 1/2"	INTEGRAL WITH COUNTERTOP	
P2	EMERGENCY EYEWASH	GUARDIAN	G1805	-	-	1/2"	-	-	DECK MOUNTED WITH SWING OPERATION	

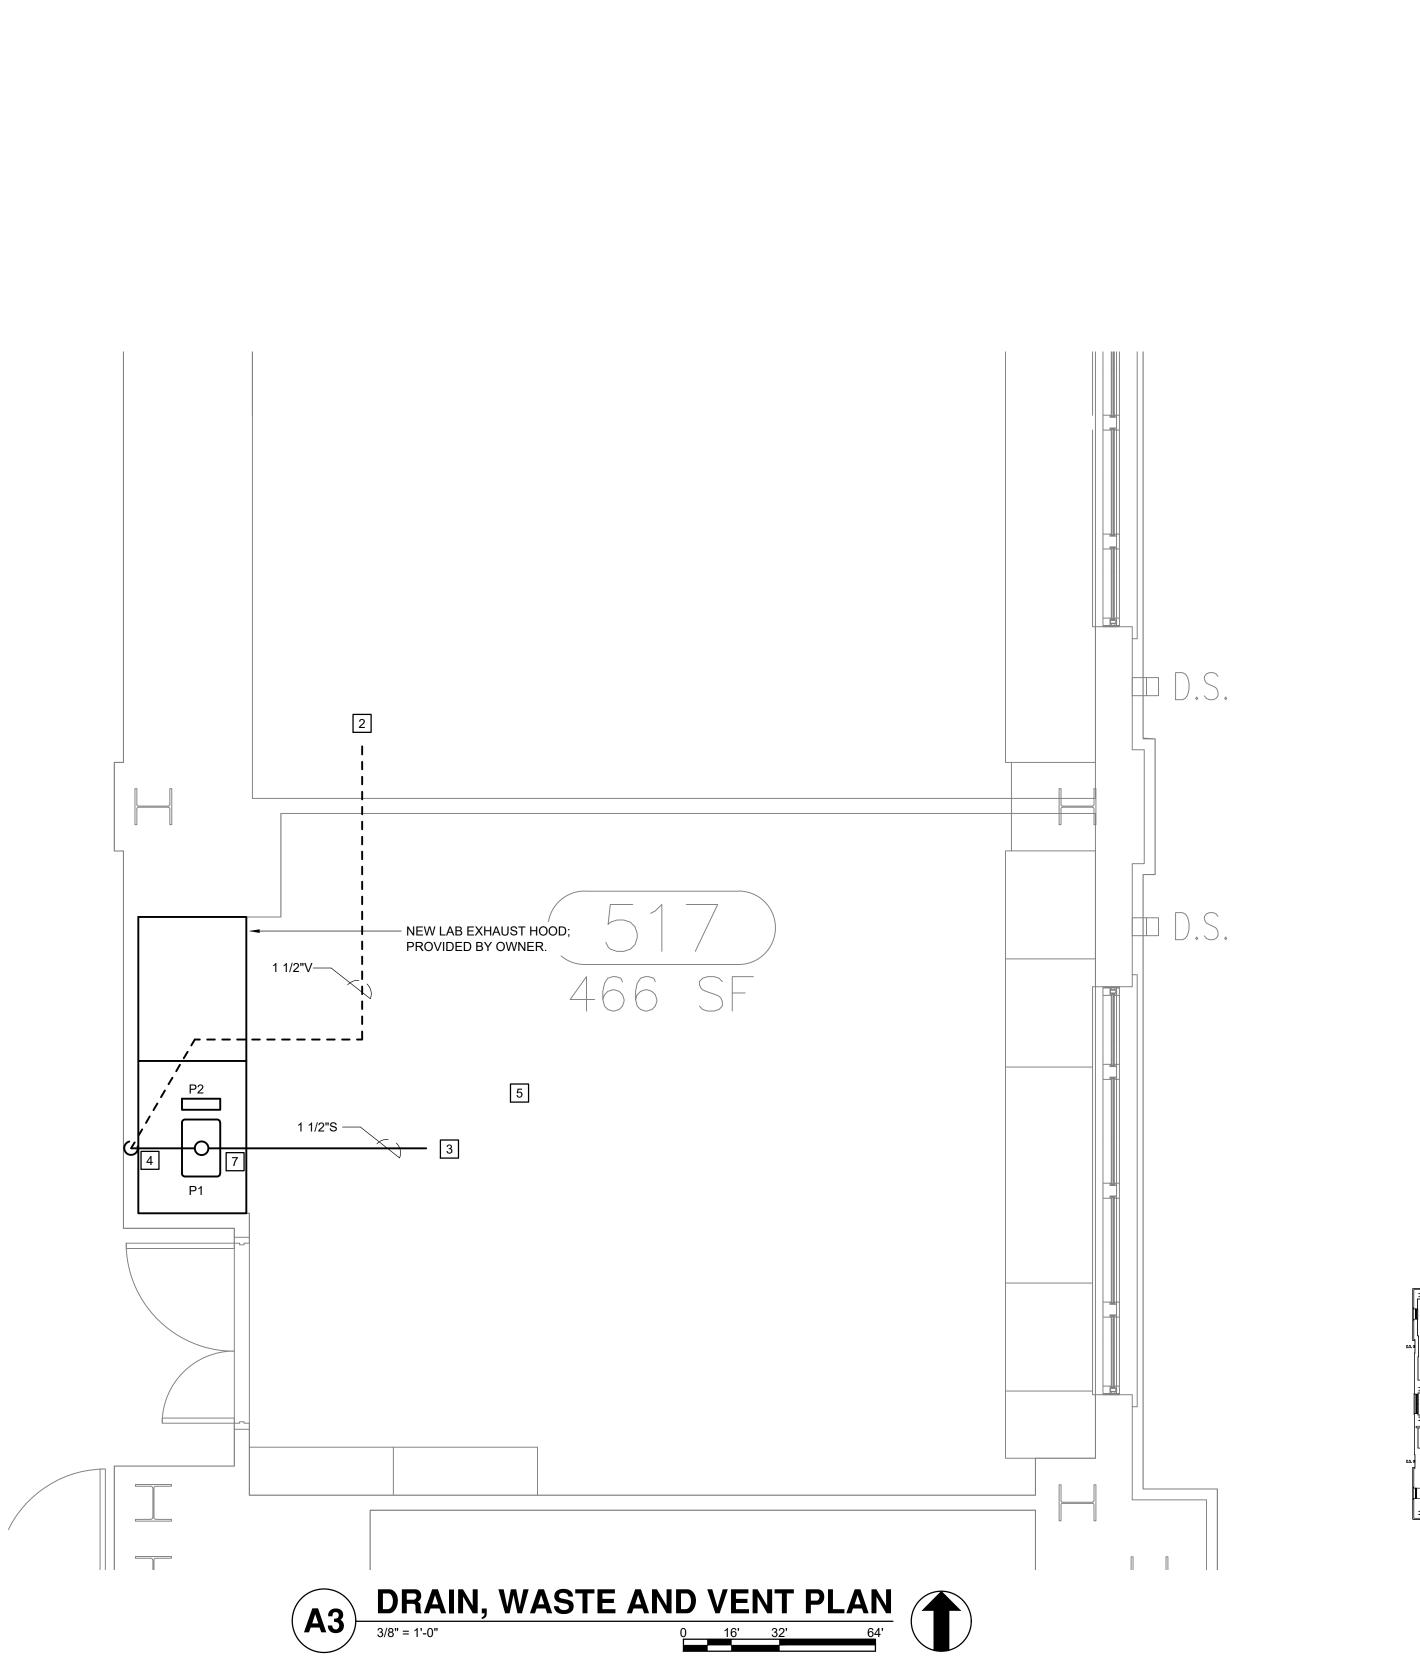

- NEW LAB EXHAUST HOOD; PROVIDED BY OWNER.

SUPPLY PLAN

3/8" = 1'-0"

0_

LEGEND

COLD WATER LINE, CW

HOT WATER LINE, HW

----- VENT LINE, V

TEPID WATER LINE, TW

SANITARY DRAIN LINE, S

CONNECTION TO EXISTING

BRANCH ISOLATION BALL VALVE

CLG CEILING

DFA DOWN FROM ABOVE

ø DIAMETER

GENERAL NOTES

- PROVIDE LABOR, EQUIPMENT AND MATERIALS TO COMPLETE THE PLUMBING WORK INDICATED ON THESE DRAWINGS AS REQUIRED BY LOCAL CODE AND ORDINANCES.
- INCLUDE WASTE, VENT, DOMESTIC COLD & HOT WATER PIPING, AS INDICATED ON THESE DRAWINGS, AS WELL AS HOOKUP OF FIXTURES AND INSULATION OF PIPING.
- INCLUDE ITEMS, SUCH AS FITTINGS, ETC. NOT MENTIONED BUT UNDERSTOOD TO BE NECESSARY TO COMPLETE THE PLUMBING
- SOIL, WASTE, VENT AND WATER PIPING MATERIALS MUST MEET OR EXCEED LOCAL CODES.
- 5. PROVIDE WATER HAMMER ARRESTERS IN ACCORDANCE WITH THE SOUTH CAROLINA PLUMBING CODE AND LOCAL ORDINANCES.
- 6. COMPLETE WORK IN ACCORDANCE WITH THE SOUTH CAROLINA PLUMBING CODE AND LOCAL ORDINANCES. SEE SPECIFICATIONS FOR PRODUCT AND INSTALLATION REQUIREMENTS.


RESULTING FROM THE FAILURE OF THESE ITEMS AT NO EXPENSE


7. GUARANTEE WORK UNDER THIS CONTRACT TO BE FREE FROM DEFECTIVE WORKMANSHIP, MATERIALS AND EQUIPMENT FOR ONE YEAR AFTER ACCEPTANCE OF THE BUILDING BY THE OWNER. SHOULD SUCH DEFECTS OCCUR DURING THE ONE YEAR PERIOD, REPAIR AND/OR REPLACE DEFECTIVE ITEMS AND DAMAGE

DRAWING NOTES

WHATSOEVER TO THE OWNER.

- 1 CONNECT TO EXISTING CW/HW/TW SUPPLY IN THIS AREA. CONTRACTOR TO FIELD VERIFY EXACT LOCATION.
- 2 CONNECT TO EXISTING VENT IN THIS AREA. CONTRACTOR TO FIELD VERIFY EXACT LOCATION.
- CONNECT TO EXISTING SANITARY IN THIS AREA.
 CONTRACTOR TO FIELD VERIFY EXACT LOCATION.
- 4 INSTALL DRAIN AND VENT RISER INSIDE WALL. PATCH AND FINISH WALL TO MATCH EXISTING.
- FREMOVE LAY-IN CEILING TILES AND GRID AS NECESSARY TO INSTALL PIPING. REINSTALL GRID AND TILES; REPLACE DAMAGED TILES WITH NEW TO MATCH EXISTING.
- 6 PROVIDE VACUUM AND COMPRESSED AIR CONNECTIONS INSIDE HOOD. INSTALL MANUAL PRESSURE VALVES MOUNTED ON EXTERIOR
- 7 PROVIDE AND INSTALL 1.5 GALLON POLYETHYLENE CHEMICAL DILUTION TANK.

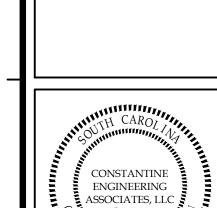


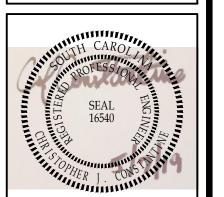

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ET, COLUMBIA, SC 29208

FP00001 921 ASSEMBLY STREET, COL

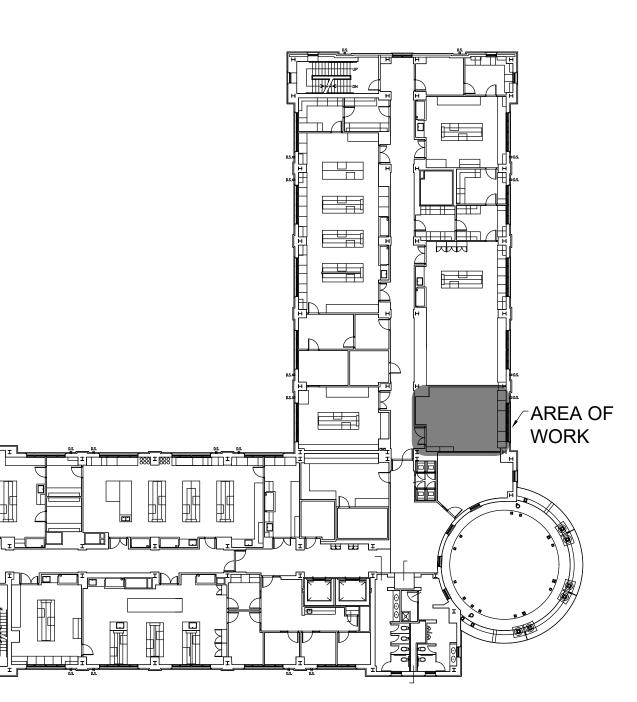

A5 KEY PLAN - 5TH FLOOR
NO SCALE

 DRAWN BY:
 MD


 CHECKED BY:
 CJ0

 DATE:
 05/07/1


19-019

SHEET NUMBER
P1.1

D1 ELEVATION - MASS SPECTROMETER
NO SCALE

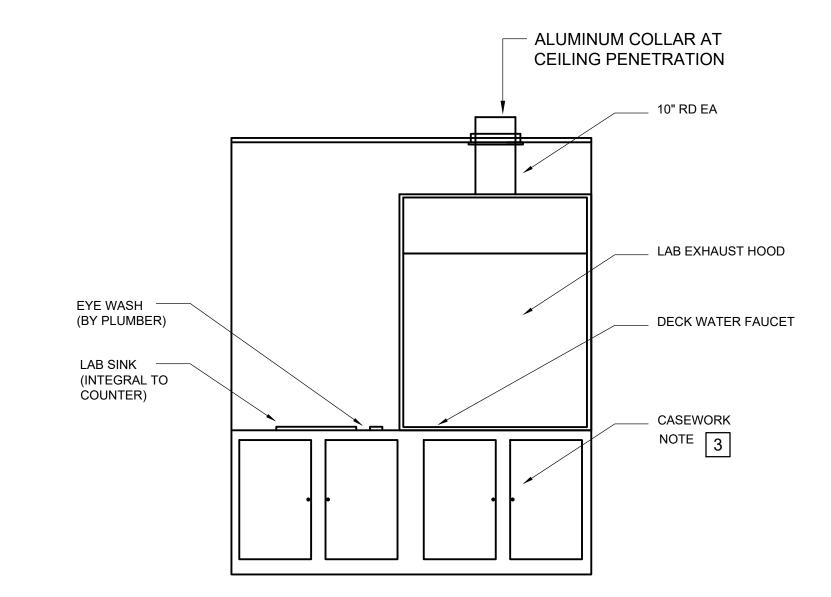

D4 ELEVATION - LAB HOOD
NO SCALE

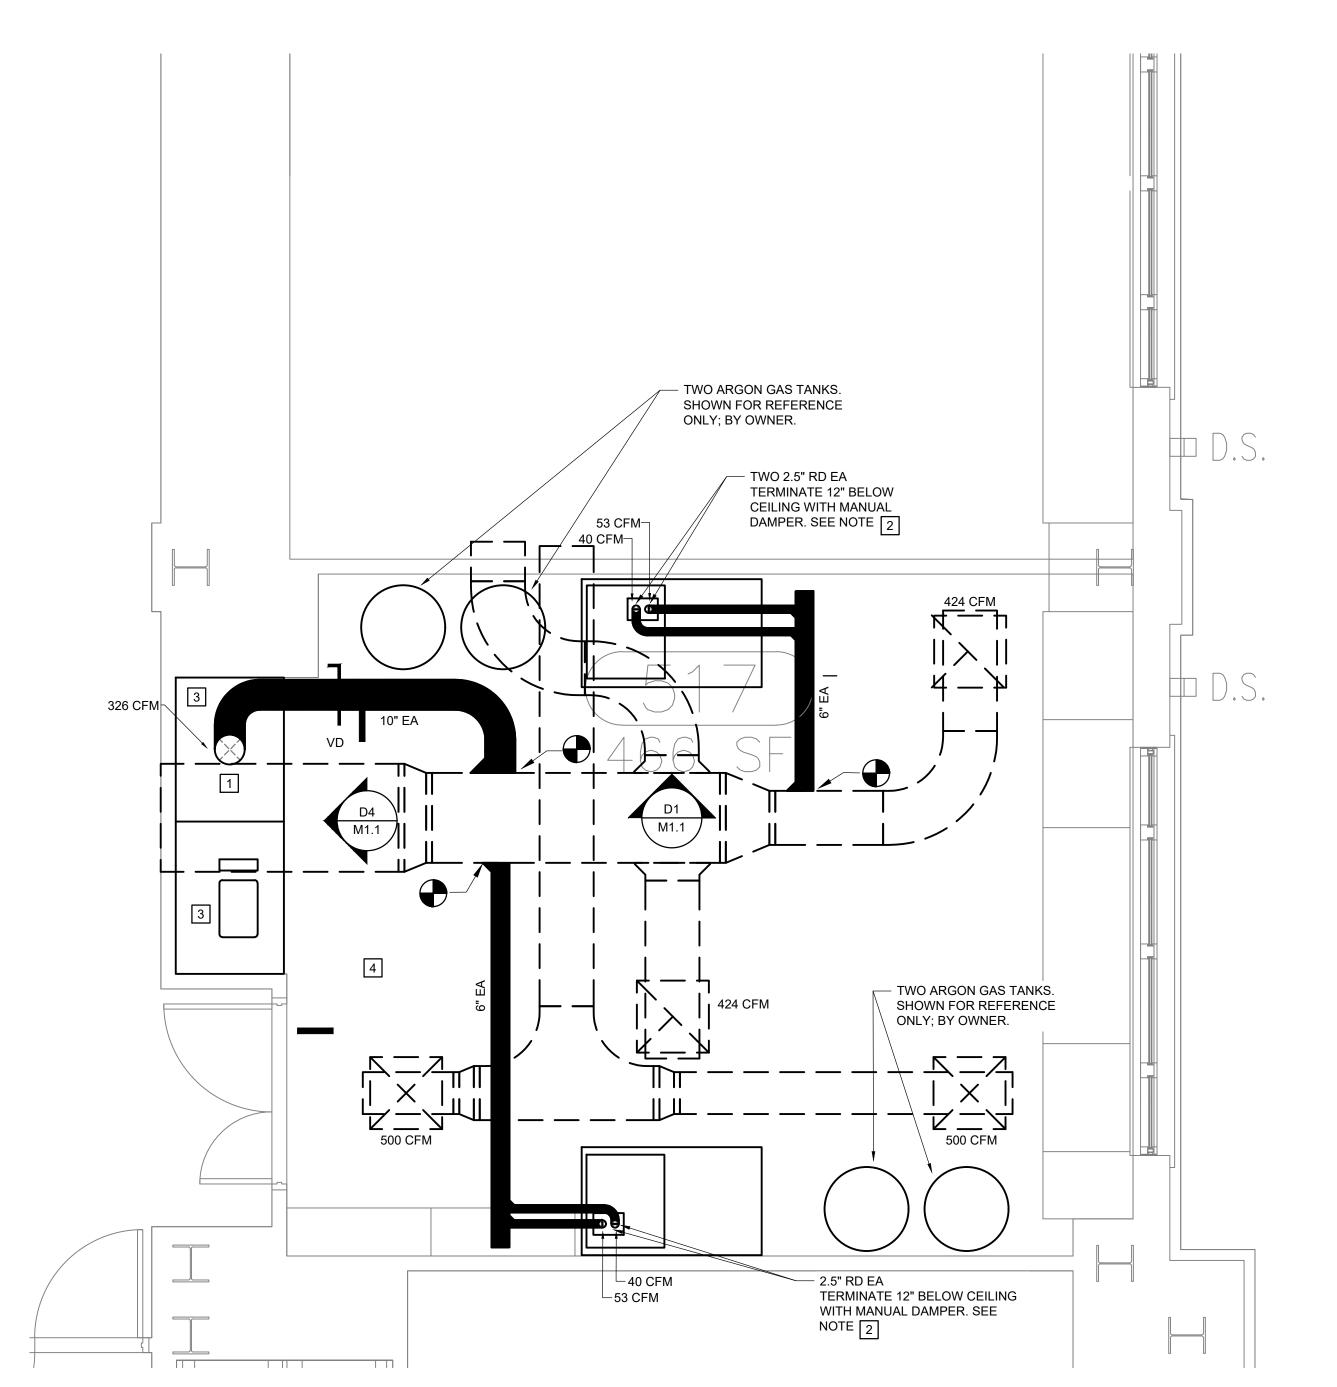

MECHANICAL PLAN

3/8" = 1'-0"

0 16' 32' 64'

LEGEND

CEILING SUPPLY DIFFUSER, EXISTING

MANUAL VOLUME DAMPER

CEILING EXHAUST GRILLE, EXISTING

SA SUPPLY AIR
EA EXHAUST AIR


CONNECTION TO EXISTING

GENERAL NOTES

- PROVIDE LABOR, MATERIALS AND EQUIPMENT TO COMPLETE THE HVAC WORK INDICATED ON THE DRAWINGS AND AS REQUIRED BY LOCAL CODES AND ORDINANCES.
- 2. FABRICATE AND INSTALL DUCTWORK IN ACCORDANCE WITH SMACNA STANDARDS.
- 3. INSTALL AND CONNECT THE HVAC SYSTEM IN STRICT ACCORDANCE WITH LOCAL CODES, ORDINANCES AND THE LATEST EDITION OF THE SOUTH CAROLINA BUILDING
- 4. ADJUST CONTROLS AND EQUIPMENT FOR PROPER OPERATION. LUBRICATE AND CLEAN EQUIPMENT PRIOR TO ACCEPTANCE OF BUILDING BY OWNER.
- 5. COORDINATE WORK WITH THE ELECTRICAL INSTALLER.
- 6. GUARANTEE WORK INSTALLED UNDER THE CONTRACT TO BE FREE FROM DEFECTIVE WORKMANSHIP AND MATERIALS, USUAL WEAR EXPECTED. SHOULD SUCH DEFECTS DEVELOP WITHIN A PERIOD OF ONE YEAR AFTER ACCEPTANCE OF THE BUILDING BY THE OWNER, REPAIR AND/OR REPLACE DEFECTIVE ITEMS AND DAMAGE, RESULTING FROM FAILURE OF THESE ITEMS, AT NO EXPENSE WHATSOEVER TO THE OWNER.


DRAWING NOTES

- INSTALL 10" Ø EXHAUST DUCT UP FROM NEW LAB HOOD (FURNISHED BY OTHERS AND INSTALLED BY CONTRACTOR) TO EXISTING 30"X12" EA DUCT ABOVE CEILING. PROVIDE MANUAL BALANCING DAMPER ABOVE CEILING.
- 2 PROVIDE 2.5" Ø INSTRUMENT EXHAUST DUCT 12" BELOW CEILING. FINAL CONNECTION AND FLEXIBLE HOSE TO EQUIPMENT TO BE PROVIDED BY OTHERS.
- CONTRACTOR TO PROVIDE CUSTOM LAB HOOD SURFACE AND CASEWORK WITH LOWER CABINETS AND SINK W/ EYEWASH. DIMENSIONS ARE APPROXIMATELY 88" WIDE X 36" DEEP. FIELD VERIFY DIMENSIONS.
- REMOVE LAY-IN CEILING TILES AND GRID AS NECESSARY TO INSTALL PIPING.
 REINSTALL GRID AND TILES; REPLACE DAMAGED TILES WITH NEW TO MATCH

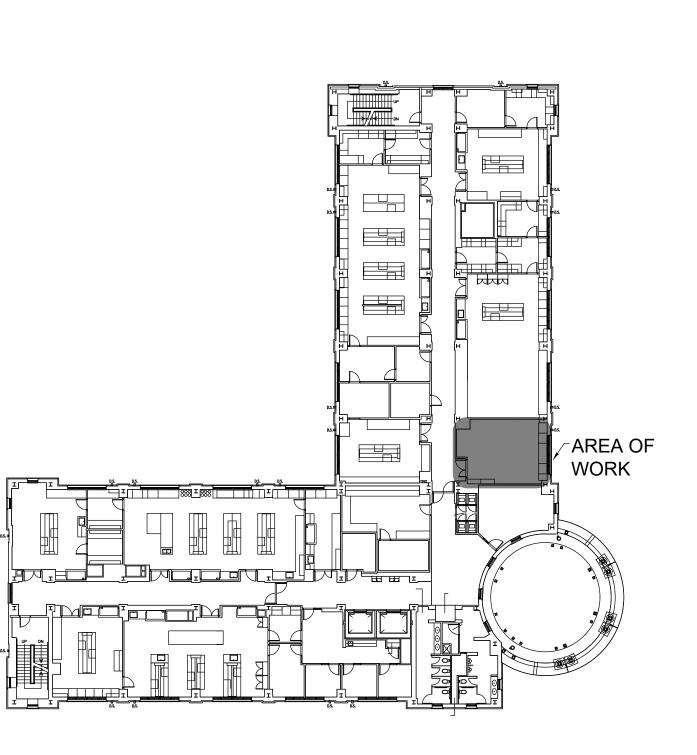


A5 KEY PLAN
NO SCALE

NSTANTINE GINEERING OCIATES, LL

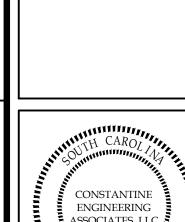



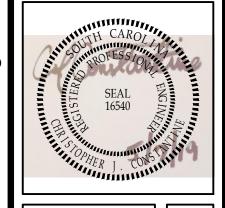

HEALTH

FP0000193
EMBLY STREET, COLUMBIA, SC

USC SCHOOL OF FP000

 DRAWN BY:
 MDI

 CHECKED BY:
 CJC

 DATE:
 05/07/19

JOB NUMBER 19-019

SHEET NUMBER


VOLTS/PHASE/WIRE: PANEL SIZE & TYPE: 120-208/3/4 225A			MAIN SIZE & TYPE: 100A MLO			CABINET: FLUSH			MIN SCC:	FED FROM:	NOTES:		
									10 KAIC				
NO	TRIP	AREA SERVED		A B C		A B C			AREA SERVED			N	
1	20	RECEPT - VENT TEACH LAB		200			1000			RECEPT- VENT TEACH LAB			2
3	20	RECEPT - VENT TEACH LAB			200			Х		SPARE			
5	20	RECEPT - VENT TEACH LAB				200			400	RECEPT- VENT TEACH LAB			6
7	20	RECEPT - VENT TI	EACH LAB	1000			1000			RECEPT- VENT TEACH LAB		20	8
9	20	SPARE			Х			Х		SPARE			1
11	20	RECEPT - VENT TI	CEPT - VENT TEACH LAB			400			1000	RECEPT- VENT TEACH LAB			1
13	20	RECEPT - VENT TI	EACH LAB	400			1000			SPARE		20	1
15	20	RECEPT - VENT TEACH LAB			1000			200		RECEPT- VENT TEACH LAB			1
17	20	FUME HOOD**				70			400	RECEPT- VENT TEACH LAB			1
19	20	RECEPT - VENT TEACH LAB		500			1100			MASS SPECTROMETER**			2
21	20*	MASS SPECTROMETER**			1100			1100					2
23	20"					1100			950	FORE VACUUM PUMP**			2
25	15*	FORE VACUUM PL	IMD**	950			950			TORE VACO	OW POWP	15*	2
27	15	FORE VACOUM PO	JIVIP		950			Х		SPECTROMETER COMPUTER**		15*	2
29	15*	SPECTROMETER	COMPUTER**			Χ			Х	SPECTROMETER MONITOR**		15*	3
31	15*	SPECTROMETER	MONITOR**	Χ			100			DATA ACQUISITION UNIT**		15*	3
33	15*	DATA ACQUISITIO	N UNIT**		100			100		TOF POWER SUPPLY**		15*	3
35	15*	TOF POWER SUPP	PLY**			100			Х	SPARE		20	3
37	20	SPARE		Χ			Χ			SPARE		20	3
39	20	SPARE			Х			Χ		SPARE		20	4
41	20	SPARE				Х			Х	SPARE		20	7

ALL BREAKERS ARE EXISTING TO REMAIN UNLESS DENOTED OTHERWISE. BREAKERS DENOTED BY A * ARE NEW. ALL CIRCUITS ARE EXISTING TO REMAIN UNLESS DENOTED OTHERWISE. CIRCUITS DENOTED BY A ** ARE NEW. EXISTING LOADS ARE BASED ON PHRC BUILDING DRAWINGS DATED "11 JUNE 2004".

PLOGILITY PLOGILITY

LEGEND

A-1,3 HOMERUN OF CIRCUIT TO PANEL - CIRCUIT NUMBERS INDICATED.

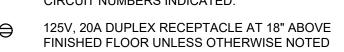



PANELBOARD, EXISTING

"c" INDICATES 42" AFF MOUNTING HEIGHT

125V, 20A QUADRAPLEX RECEPTACLE AT 18" ABOVE
FINISHED FLOOR UNLESS OTHERWISE NOTED

→ 250V, 20A SINGLE RECEPTACLE★ EXISTING COMMUNICATIONS OUTLET

CLE

GENERAL NOTES

 FURNISH ALL MATERIALS AND LABOR NECESSARY TO PROVIDE COMPLETE AND PROPERLY OPERATING ELECTRICAL SYSTEMS. FURNISH ALL MATERIALS AND LABOR NECESSARY TO DEMONSTRATE TO THE OWNER AND TO THE ENGINEER THAT ALL SYSTEMS ARE OPERATING PROPERLY AND AS SPECIFIED. WARRANTY ALL WORK AND ALL MATERIALS, EQUIPMENT AND DEVICES FOR A PERIOD OF ONE YEAR AFTER OWNER'S ACCEPTANCE.

- ENSURE THAT ALL WORK CONFORMS TO THE LATEST EDITION OF:
 2.1. ANSI/NFPA 70 (NATIONAL ELECTRICAL CODE)
- 2.2. NECA STANDARD OF INSTALLATION
- 2.3. SOUTH CAROLINA BUILDING CODE2.4. NFPA 101 (LIFE SAFETY CODE)

CEILING GRID OR GRID HANGER WIRES.

2.5. ALL FEDERAL, STATE AND LOCAL CODES AND ORDINANCES2.6. LOCAL UTILITY COMPANY REGULATIONS


CLASSIFIED BY U.L. AS SUITABLE FOR THE PURPOSE USED.

- 3. ALL MATERIALS, EQUIPMENT AND DEVICES AS A MINIMUM SHALL MEET THE REQUIREMENTS OF U.L. (WHERE U.L. STANDARDS ARE ESTABLISHED FOR THOSE ITEMS) AND THE REQUIREMENTS OF THE NFPA 70. ALL ITEMS SHALL BE
- COORDINATE LOCATION OF ELECTRICAL DEVICES AND ELECTRICAL WORK WITH OTHER TRADES TO AVOID CONFLICTS AND INTERFERENCES. NUMBERS ADJACENT TO DEVICES ARE NOMINAL MOUNTING HEIGHTS.
- 5. PROVIDE ALL THE INTERCONNECTING POWER WIRING AND CONDUIT, CONTROL WIRING (RATED 120 VOLTS (NOMINAL)) AND CONDUIT, AND THE ELECTRICAL POWER CIRCUITS FOR ALL EQUIPMENT PROVIDED BY OTHER TRADES.
- 6. PROVIDE MINIMUM SIZE OF #12 CONDUCTOR FOR 20A POWER CIRCUITS LESS THAN 75'-0" IN LENGTH. OTHERWISE,
- PROVIDE MINIMUM CONDUCTOR SIZE OF #10. INSTALL ALL WIRING IN CONDUIT UNLESS NOTED OTHERWISE.

 7. SUPPORT ALL CONDUIT ABOVE CEILING FROM BUILDING STRUCTURAL MEMBERS OR CONCRETE DECKING, NOT FROM
- 8. WHERE CONDUIT PENETRATES FIRE RATED BARRIERS (WALLS, FLOORS AND CEILINGS), SEAL THE OPENING AROUND THE CONDUIT TO MAINTAIN THE FIRE RATING OF THE BARRIER WITH U.L. LISTED FIRE STOPPING MATERIAL.
- 9. PROVIDE TYPEWRITTEN DIRECTORY FOR PANEL TO INCLUDE ALL EXISTING AND NEW CIRCUITS. DIRECTORY SHALL IDENTIFY PANELBOARD AND INDICATE EACH CIRCUIT NUMBER, DESCRIPTION AND LOCATION.


DRAWING NOTES


1 EXISTING TO REMAIN.

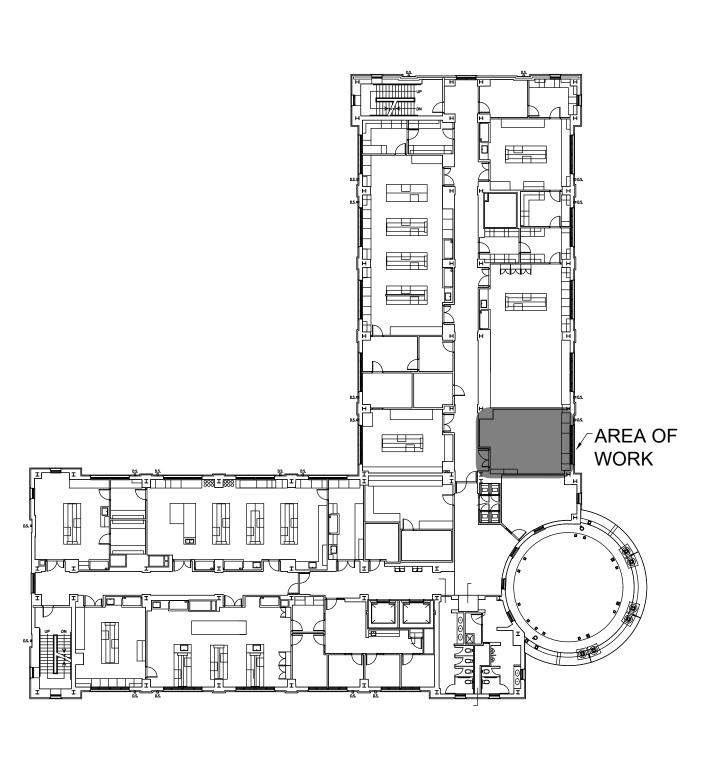



NSTANTINE GINEERING OCIATES, LI

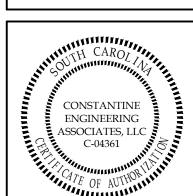

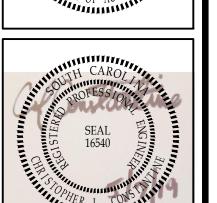

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FP00000193
MBLY STREET, COLUMBIA, SC

F'POUUC 921 ASSEMBLY STREET, CO

DRAWN BY: JC:
CHECKED BY: CJ

JOB NUMBER 19-019

SHEET NUMBER